Elm Place Application for Ch. 40B Permit

Prepared for the Zoning Board of Appeals

November 30, 2021



Table of Contents – Elm Place

- ➤ Introductions & 40B Project Overview
- Project Team
- ➤ Anticipated Unit Mix and Affordability
- ➤ Project Site
- Design Details, including how the project has been updated from the January 2021 Submission, and renderings
- ➤ Traffic & Parking



Project Team



Gilbert J. Winn
Chief Executive Officer,
WinnCompanies



Angela Gile

Project Director,

WinnDevelopment



Mike D. Binette
Senior Partner + Managing Principal
The Architectural Team



Michael O'Brien

Executive Vice President,

WinnCompanies



Bruce Paradise
Property Owner



Andrew Stebbins
Senior Project Manager
The Architectural Team



Adam Stein

Executive Vice President,

WinnDevelopment



Barry Turkanis
Property Owner



Deb ColbertSenior Project Manager
Hancock Associates



Chris Drucas, Esq General Counsel



Jeff Dirk *Managing Partner*Vanasse & Associates Inc.



Project Summary – Elm Place



- Background
- Project
- DHCD Approval
- Proposal



Community Engagement Process

- Since October 2020 the project team has been meeting with Town Departments and Commissions and holding community meetings to go over the project and get feedback
- Most recently on Nov. 8th and Nov. 15th the project team heard comments from the Planning Board at two public meetings

 The Town of Swampscott conducted a Traffic Peer Review and is in the process of conducting a Utility Peer Review





Adjustments Through Community Engagement Process

ltem	January 2021 Application	September 2021 Update
Height	60' from Street Level (Essex and Pitman)	45' from Street Level (Essex and Pitman)
Stories	5 Stories	2 Stories (Essex), 4-5 Stories (Pitman), 5 Stories (Tracks)
Density	128 Units	120 Units
Parking	108 (.84 Ratio)	128 (1.06 ratio)
Architectural Style	Modern	New England Coastal
Emergency Access	Fire Dept. not yet reviewed	Fire Department has reviewed and approved most recent plans
Traffic & Parking	Studies in progress	Traffic Impact Analysis and Parking Demand Analysis complete. Creatively added more project parking.
Accommodation of future potential Rail Trail landing space from rail crossing		Continue to support Town's efforts



Anticipated Unit Mix and Affordability

- Decreased number of units from 128 to 120, but the mix of unit types has remained the same
- 42% Affordable, 58% Market/Middle Income
- All 120 project units count toward SHI

Unit Mix					
Unit Type	Studio	1 Bed	2 Bed	3 Bed	Total
Market	1	29	8	0	38
Workforce/Middle-Income					
ranging from 80%-120% AMI	2	19	5	1	27
At or below 60% AMI	2	24	7	6	39
At or below 30% AMI	2	5	4	5	16
Total	7	77	24	12	120

Example qualifying incomes for a two-person household:


At or below 80% - \$85,920


At or below 60% - \$64,440


At or below 30% - \$32,220



Project Summary – Project Site

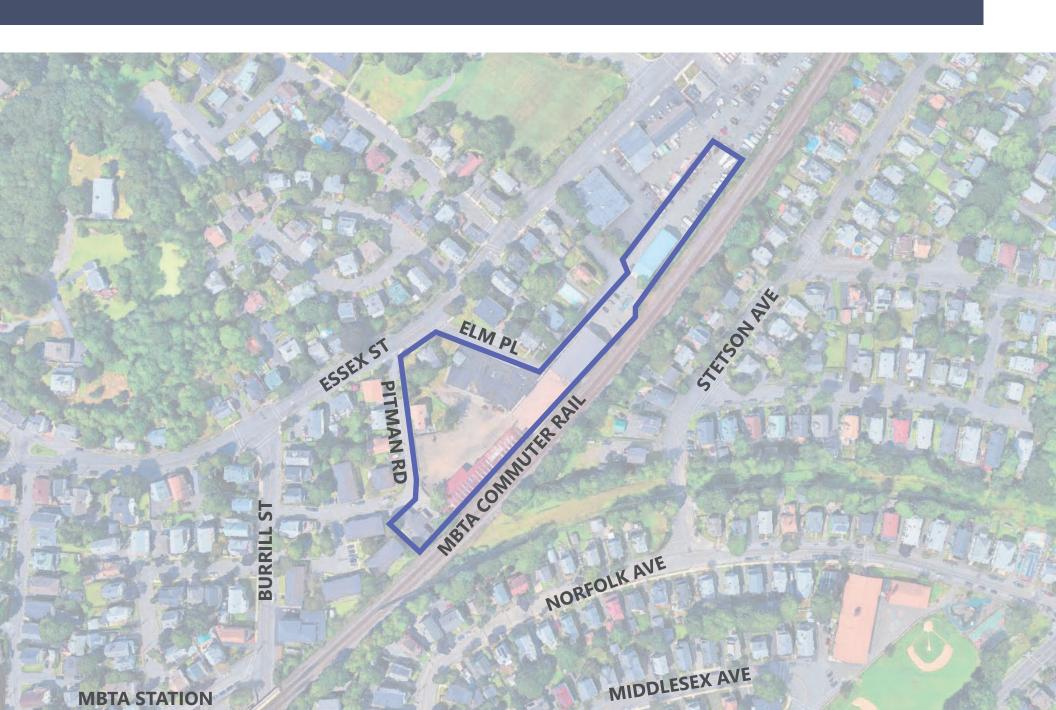

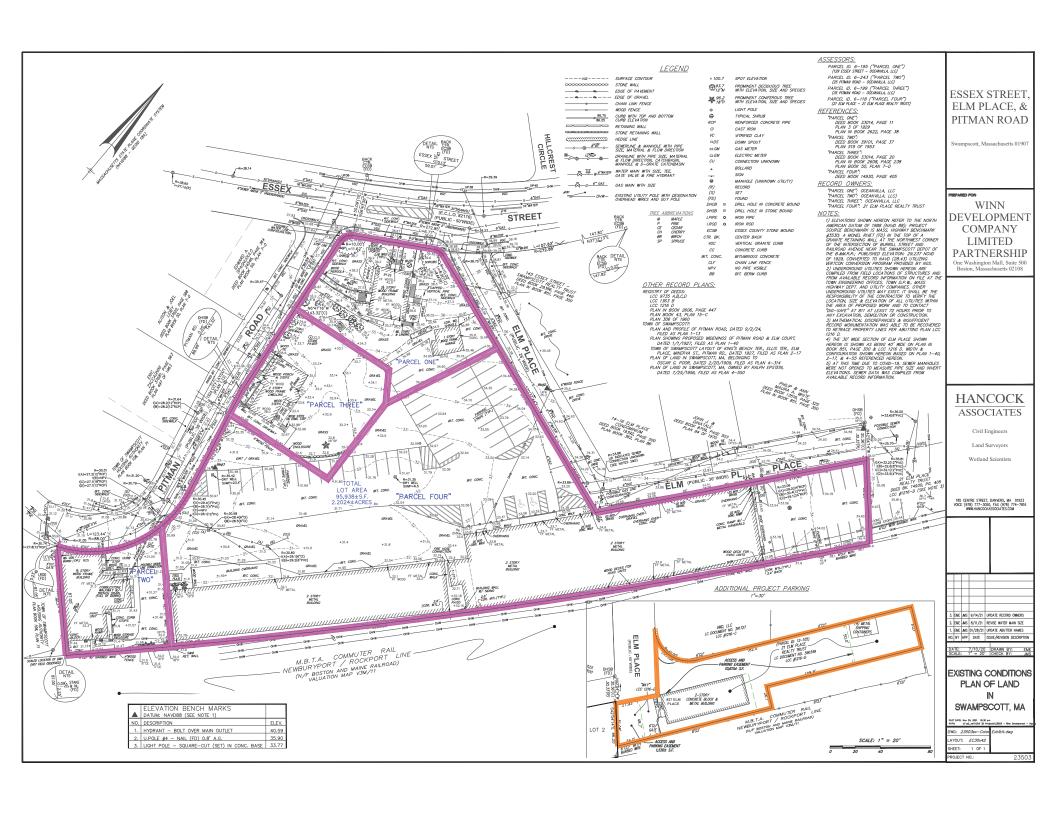

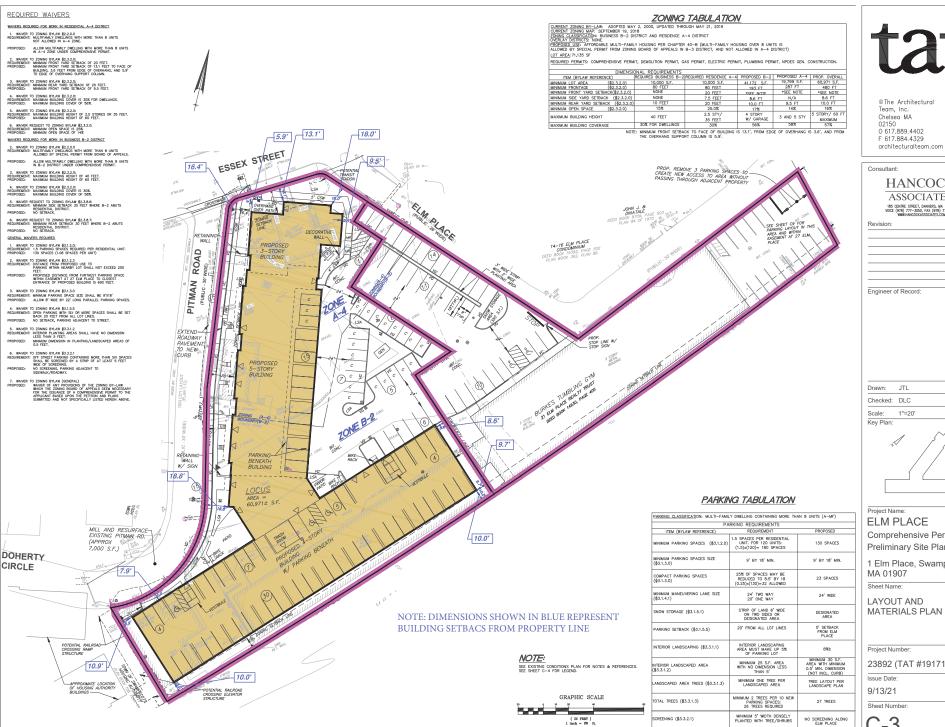

0 617.889.4402 F 617.884.4329

HANCOCK ASSOCIATES

185 CENTRE STREET, DANVERS, MA 01923 VOICE (978) 777-3050, FAX (978) 774-7816

ELM PLACE


Comprehensive Permit Preliminary Site Plan

1 Elm Place, Swampscott,

MATERIALS PLAN

23892 (TAT #19171)

ESSEX STREE! © The Architectural Team, Inc. Chelsea MA 02150 8=38.14 0 30 DRANGO ESSEX 0 617.889.4402 F 617.884.4329 architecturalteam.com Consultant: PITMAN ROADS **HANCOCK** 14-16 ELM PLACE CONDOMINIUM ASSOCIATES 185 CENTRE STREET, DANVERS, MA 01923 VOICE (978) 777-3050, FAX (978) 774-7816 Revision: ON & TC/BC--Engineer of Record: LEGEND EXISTING PROPOSEL SURFACE CONTOUR FENCE OR RAILING 100 SEWERLINE & MANHOLE WITH PIPE SIZE, MATERIAL & FLOW DIRECTION DRAINLINE WITH PIPE SIZE, MATERIAL & FLOW DIRECTION, CATCHBASIN, SLAB EL = 35.5 era w WV 10°01 G GAS MAIN WITH SIZE & GATE VALVE Drawn: JTL BC=31.86 TC=32.36 232.6 SPOT ELEVATION Checked: DLC LIGHT POLE Scale: 1"=20' Key Plan: CATCH BASIN DRILL HOLE IN STONE BOUND CONCRETE BOUND WITH NO DRILL HOLE STONE BOUND WITH NO DRILL HOLE DRAIN MANHOLE SEWER MANHOLE FOUND RECORD HELD REINFORCED CONCRETE PIPE IRON PIPE CAST IRON DUCTILE IRON CORRUGATED PLASTIC PIPE Project Name: POLYWNYL CHLORIDE **ELM PLACE** POLYVANY, CHLORIDE SLOPED GRANTE CURB VERTICAL GRANTE CURB CONCRETE SIDEWALK UTILITY POLE FIRE HYDRANT LANDSCAPE AREA VG Comprehensive Permit \mathfrak{A} Preliminary Site Plan WATER VALVE GAS VALVE FIRST FLOOR ELEVATION 1 Elm Place, Swampscott, MA 01907 INTEGRAL CURB AND SIDEWALK CAST-IN-PLACE SAWCUT LINE Sheet Name: COMPACT PARKING SPACE GENERAL NOTES **GRADING AND** DRAINAGE PLAN 1.0 TOPOGRAPHIC, PROPERTY LINE AND PERMIT INFORMATION THE HORDER OF CONTRACTOR THE CONTRACTOR SECRETARY CAUTIONED THAT THE LOCATION AND/OR ELEVATION OF DISTINGUILLIES AND STRUCTURES AS SHOWN ON THESE PLANS IS BASED ON RECORDS OF WORKUS UTILITY ORDERINGS AND WRISE POSSIBLE, MUSICIPATION TO THE FIRED. THIS WORKINGTON WORKUS UTILITY ORDERINGS AND WRISE POSSIBLE, MUSICIPATION TO THE FIRED. THIS WORKINGTON STRUCTURES SHALL BE VERTED IN THE FIELD BY THE CONTRACTOR PRICE TO THE STRAT OF CONSTRUCTION TO CONTRACTOR WISE CONTRACT THE PROPERSHER UTILITY AND CORRESTING PERTURNING AUTHORITY AND TOGGET Z'Z HOURS FROM ID ANY DECAMBION WHIN TO REQUEST BEACH FIRED. LOCATIONS OF UTILITIES CONTRACTOR AND APPROPARE REPORTAL ACTION SHALL BE FARM FROM FORCED THE WISE OF SHALL BE IT THE RESPONSIBILITY OF THE CONTRACTOR TO RELOCATE ALL EXISTING UTILITIES WHICH CONTRACTOR SHALL BE THE RESPONSIBILITY OF THE CONTRACTOR TO RELOCATE ALL EXISTING UTILITIES WHICH CONTRACTOR. EXISTING 18" LINE TO -RALPOAD TO BE TV INSPECTED TO ENSURE GOOD CONDITION Project Number: 23892 (TAT #19171) 1.2: PROPERTY LINE AND TOPOGRAPHY: SEE EXISTING CONDITIONS PLAN PREPARED BY HANCOCK ASSOCIATES. Issue Date: GRAPHIC SCALE 9/13/21 1.4: BENCHMARKS: SEE EXISTING CONDITIONS PLAN Sheet Number: 1.5: FLOODPLAIN: THE PROJECT SITE FALLS OUTSIDE OF THE FEDERAL EMERGENCY MANAGEMENT AGENCY FLOOD INSURANCE RATE MAP REVISED TO JULY 16, 2014 (REF: MAP NUMBER 25009C0531G). 1.6: WETLANDS: NO WETLANDS ARE PRESENT WITHIN 500' OF THE PROJECT SITE.

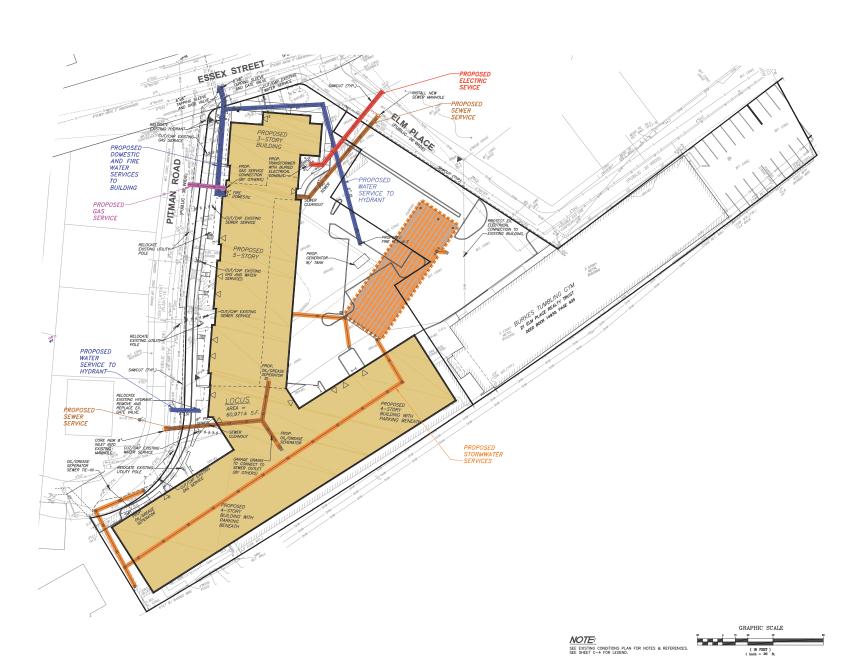

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Revision:

Engineer of Record:

Drawn: JTL

Checked: DLC Scale: 1"=20

Key Plan:



Project Name:

ELM PLACE

Comprehensive Permit Preliminary Site Plan

1 Elm Place, Swampscott, MA 01907

Sheet Name:

UTILITIES PLAN

Project Number:

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Issue Date:

9/13/21

Sheet Number:



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Key Plan:



Project Name:

ELM PLACE

Comprehensive Permit Preliminary Site Plan

1 Elm Place, Swampscott, MA 01907

Sheet Name:

LANDSCAPE PLAN

Project Number:

23892 (TAT #19171)

Issue Date:

9/13/21

Sheet Number:

ESSEX STREET NOTE: SEE EXISTING CONDITIONS PLAN FOR NOTES & REFERENCES. SEE SHEET C-4 FOR LEGEND.

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Checked: DLC

Scale: 1"=20 Key Plan:



Project Name:

ELM PLACE

Comprehensive Permit Preliminary Site Plan

1 Elm Place, Swampscott, MA 01907

Sheet Name:

DEMOLITION AND EROSION CONTROL PLAN


Project Number:

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Checked: DLC

Scale: 1"=20'

Key Plan:

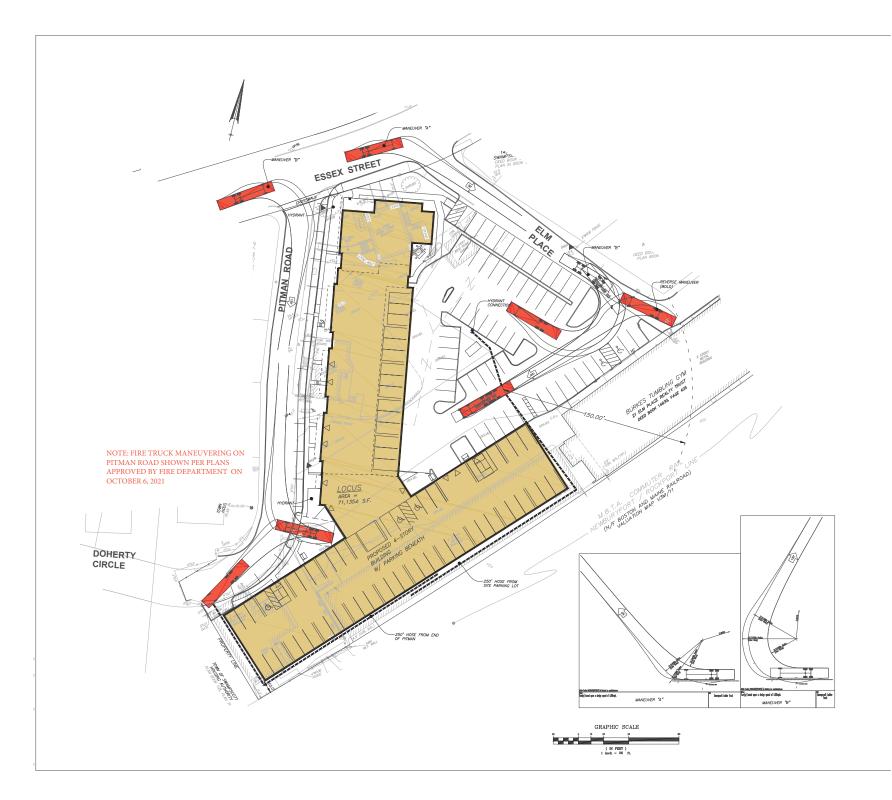

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1 Elm Place, Swampscott, MA 01907

Sheet Name:

EMERGENCY VEHICLE SWEPT PATH ANALYSIS PLAN


Project Number:

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Issue Date:

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Sheet Number:



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Engineer of Record:

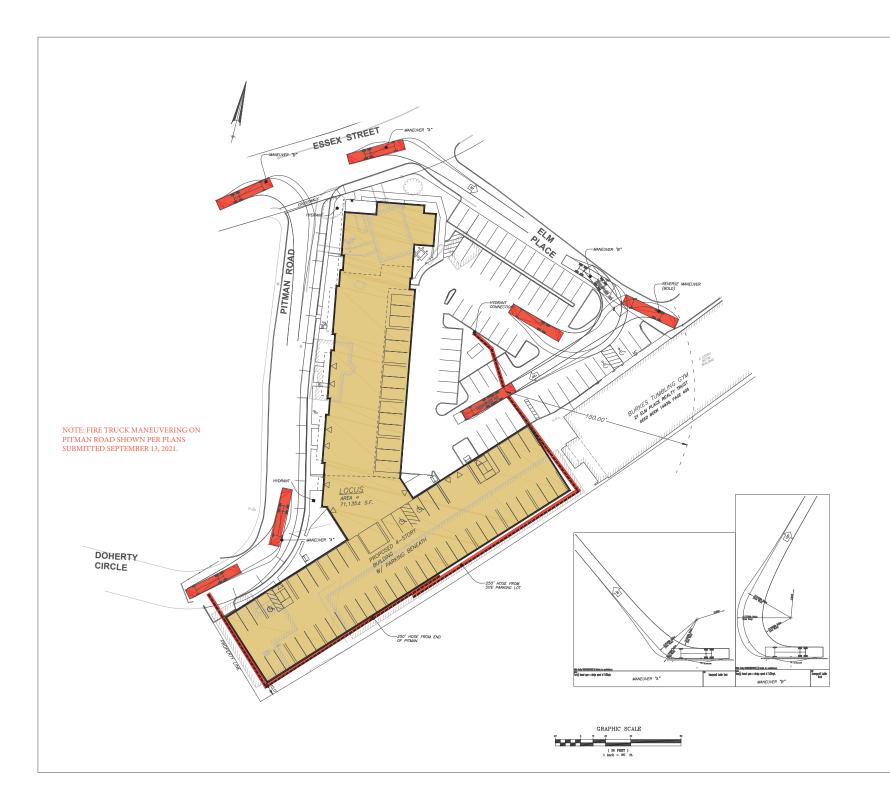

Drawn: JTL

Checked: DLC

Key Plan:

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ELM PLACE

Comprehensive Permit Preliminary Site Plan

1 Elm Place, Swampscott, MA 01907

Sheet Name:

EMERGENCY VEHICLE SWEPT PATH ANALYSIS PLAN

Project Number:

23892 (TAT #19171)

Issue Date:

9/13/21

Sheet Number:



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Engineer of Record:

Drawn: JTL

Checked: DLC/JTL

Scale: 1"=20'

Key Plan:



Project Name:

ELM PLACE

Comprehensive Permit Preliminary Site Plan

1 Elm Place, Swampscott, MA 01907

Sheet Name:

PARKING EASEMENT EXHIBIT PLAN


Project Number:

23892 (TAT #19171)

Issue Date:

9/13/21

Sheet Number:

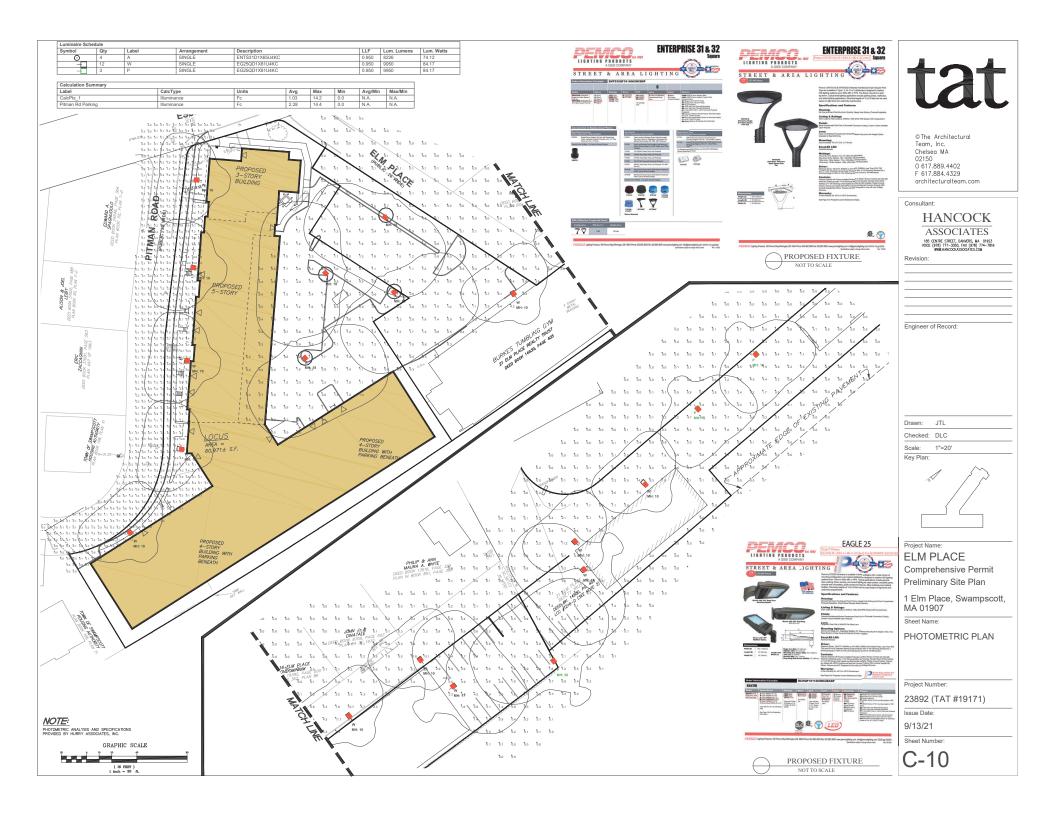

Height and Density – January 2021 Application



128 Units

5 Stories

60' from Essex/Pitman street level to top of building

Height and Density – Current Project Proposal



Architectural Style - January 2021 Application



Architectural Style – Current Project Proposal



New England Coastal Style Mansard and Gable Roofs

Soft Pastel Color Palette Traditiona Siding Classical Columns

Double-Hung Windows







Elm Place Swampscott, Massachusetts



Transportation Impact Assessment Summary

Prepared by:



November 30, 2021


Transportation Impact Assessment Summary

- Prepared in accordance with MassDOT's Transportation Impact Assessment (TIA)
 Guidelines and includes a detailed assessment of traffic volumes, pedestrian and
 bicycle accommodations and public transportation services;
- Peer review by WoldTech has affirmed the methodology and findings of the TIA and requested that the study area be expanded to include 2 additional intersections (Essex Street/Hillcrest Circle and Essex Street/Essex Terrace);
- Traffic volumes were adjusted following MassDOT's guidelines for data collected during the COVID-19 pandemic and used pre-COVID data to establish adjustment factors;
- The analysis concluded that the Project will not result in a significant impact (increase) on motorist delays or vehicle queuing over Existing or anticipated future conditions without the Project (No-Build conditions), with all movements shown to continue to operate at acceptable levels (LOS "D" or better);
- No apparent safety deficiencies were noted with respect to the motor vehicle crash history at the study area intersections; and
- Lines of sight to and from Elm Place (south) at its intersection with Essex Street and at the Project site driveway intersection with Elm Place were found to exceed the required minimum distances for safe operation.





Site Location Map

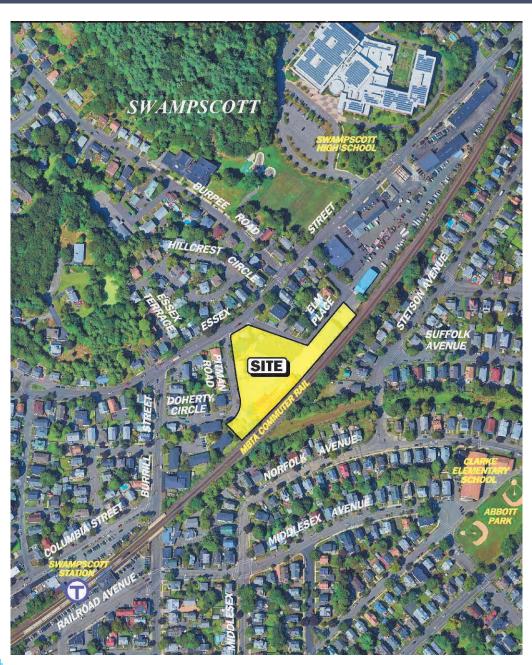







Existing Conditions

Legend: **Signalized Intersection Unsignalized Intersection Bus Stop** Sidewalk Crosswalk Lane Use and Travel Lane Width PRIVATE DRIVEWAY PRIVATE DRIVEWAY SITE









Trip Generation Summary

		Person Trips						
Time Period/Direction	ITE Vehicle Trips ^a	Total Person Trips ^b	Automobile Person Trips (83%)	Transit Trips (15%)	Pedestrian/ Bicycle Trips (2%)	Automobile Trips ^c		
Average Weekday Daily: Entering Exiting Total	348	393	326	59	8	289		
	<u>348</u>	<u>393</u>	<u>326</u>	<u>59</u>	<u>8</u>	<u>289</u>		
	696	786	652	118	16	578		
Weekday Morning Peak Hour: Entering Exiting Total	11	13	11	2	0	10		
	<u>33</u>	<u>37</u>	<u>30</u>	<u>6</u>	<u>1</u>	<u>26</u>		
	44	50	41	8	1	36		
Weekday Evening Peak Hour: Entering Exiting Total	34	38	31	6	1	27		
	<u>22</u>	<u>25</u>	<u>21</u>	<u>4</u>	<u>0</u>	<u>19</u>		
	56	63	52	10	1	46		

^aBased on ITE LUC 221, *Multifamily Housing (Mid-Rise)*, 128 units.








bITE vehicle trips x 1.13 persons per vehicle.

^cAutomobile person trips divided by 1.13.

Trip Distribution

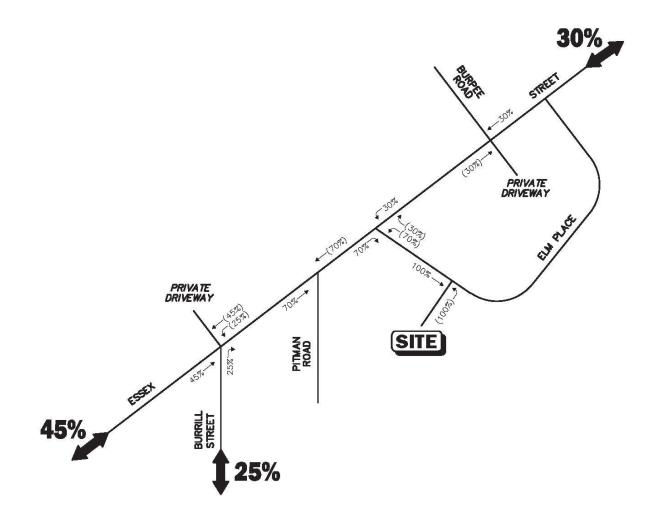









Parking Demand Observations

	Weekday Parking Ratio per Unit				Saturday Parking Ratio per Unit			
Time	Vantage Pointe Apartments ^a	Bell North Shore Apartments ^b	Hamilton Highlands ^c	Average	Vantage Pointe Apartments ^a	Bell North Shore Apartments ^b	Hamilton Highlands ^c	Average
5:00 AM	1.40	0.86	1.08	1.11	1.35	0.85	1.05	1.08
5:15 AM	1.39	0.88	1.06	1.11	1.35	0.85	1.05	1.08
5:30 AM	1.36	0.88	1.05	1.10	1.33	0.83	1.05	1.07
5:45 AM	1.32	0.86	1.05	1.08	1.34	0.83	1.05	1.07
6:00 AM	1.32	0.86	1.03	1.07	1.34	0.81	1.05	1.07
6:15 AM	1.28	0.86	1.01	1.05	1.35	0.80	1.03	1.06
6:30 AM	1.27	0.85	1.00	1.04	1.35	0.80	1.03	1.06
6:45 AM	1.21	0.78	1.00	1.00	1.35	0.76	1.01	1.04
7:00 AM	1.20	0.76	1.01	0.99	1.31	0.73	1.01	1.02
7:15 AM	1.15	0.75	1.00	0.97	1.28	0.73	0.99	1.00
7:30 AM	1.14	0.75	0.97	0.95	1.26	0.75	0.96	0.99
7:45 AM	1.07	0.73	0.95	0.92	1.25	0.71	0.92	0.96
8:00 AM	1.06	0.73	0.92	0.90	1.21	0.68	0.91	0.93

^aVantage Pointe Apartments located at 100 Vantage Terrace, Swampscott, Massachusetts with 96 units and 189 parking spaces.





^bBell North Shore Apartments located at 1 Carol Way, Salem, Massachusetts with 59 units and 74 parking spaces. ^cHamilton Highlands located at 757 Highland Avenue, Needham, Massachusetts with 77 units and 116 parking spaces.

Recommendations – Site Access

- ► The Project site driveway should be a minimum of 24 feet in width and designed to accommodate the turning and maneuvering requirements of emergency vehicles.
- Where perpendicular parking is proposed, the drive aisle behind the parking should be a minimum of 23 feet in order to facilitate parking maneuvers.
- Vehicles exiting the Project site should be placed under STOP-sign control with a marked STOP-line provided.
- All signs and pavement markings to be installed within the Project site should conform to the applicable standards of the Manual on Uniform Traffic Control Devices (MUTCD).
- ADA compliant wheelchair ramps should be provided at all pedestrian crossings that are constructed or modified as a part of the Project.
- Signs, landscaping and snow accumulations within intersection sight triangle areas should be designed and maintained so as not to restrict lines of sight.





Recommendations – Off-Site

Essex Street/Elm Place (South)

- Install a marked STOP-line be provided on the Elm Place (south) approach
- Install a double-yellow centerline along Elm Place for a minimum distance of 50-feet

Essex Street Traffic Signal System

 Design and implement an optimal traffic signal timing, phasing and coordination plan for the intersections of Essex Street with Burrill Street and Essex Street at Burpee Road





Transportation Demand Management Program

- A transportation coordinator will be designated to coordinate the TDM program;
- Information regarding public transportation services, maps, schedules and fare information will be posted in a central location and/or otherwise made available to residents;
- ▶ A "welcome packet" will be provided to residents detailing available public transportation services, bicycle and walking alternatives, and commuter options available;
- Work-at-home workspaces will be provided to support telecommuting by residents;
- Pedestrian accommodations will be incorporated into the Project and consist of connections to existing sidewalks and ADA compliant wheelchair ramps;
- An internal mail room will be provided within the building; and
- Secure bicycle parking will be provided.





Q&A



End of ZBA Presentation

 The following slides contain additional information about the project based on comments received from community meetings.





Norfolk Ave Perspective



Stetson Ave Perspective



Elm Place Perspective





EXTERIOR ELEVATION NORTH EAST - ELM PLACE Scale: 1/16" = 1'-0"



EXTERIOR ELEVATION EAST - ELM PLACE





12 EXTERIOR ELEVATION NORTH - ESSEX STREET
Scale: 1/16" = 1'-0"





EXTERIOR ELEVATION SOUTH WEST - PITMAN ROAD Scale: 1/16" = 1'-0"





LEVEL 5 79'-0"

LEVEL 4 68'-10"

LEVEL 3 58'-2"

LEVEL 2 47'-6"



13 EXTERIOR ELEVATION SOUTH WEST - PITMAN ROAD
Scale: 1/16" = 1'-0"







12 EXTERIOR ELEVATION NORTH WEST - PITMAN ROAD
Scale: 1/16" = 1'-0"



0 EXTERIOR ELEVATION SOUTH EAST - TRAIN TRACKS




Traffic Mitigation: Design Amenities


Design Amenities to Accommodate Remote Work


Concept Exploration

- Three amenity spaces with tables, desks, collaborative spaces and Wifi

In-Unit work from home workspaces

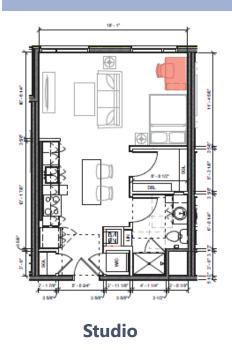


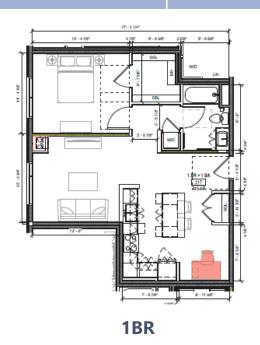


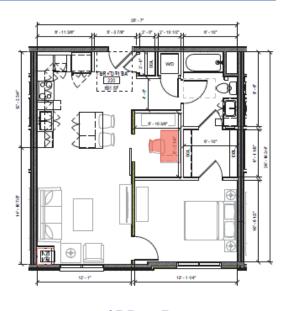

Traffic Mitigation: Design Amenities



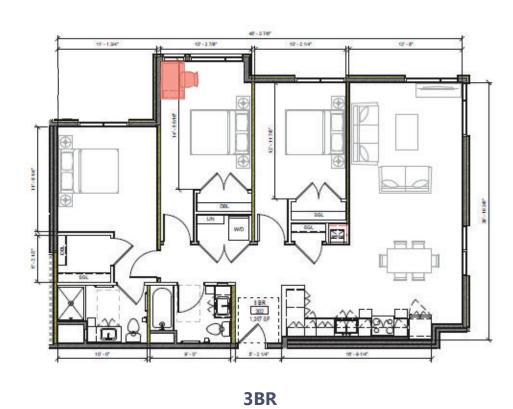

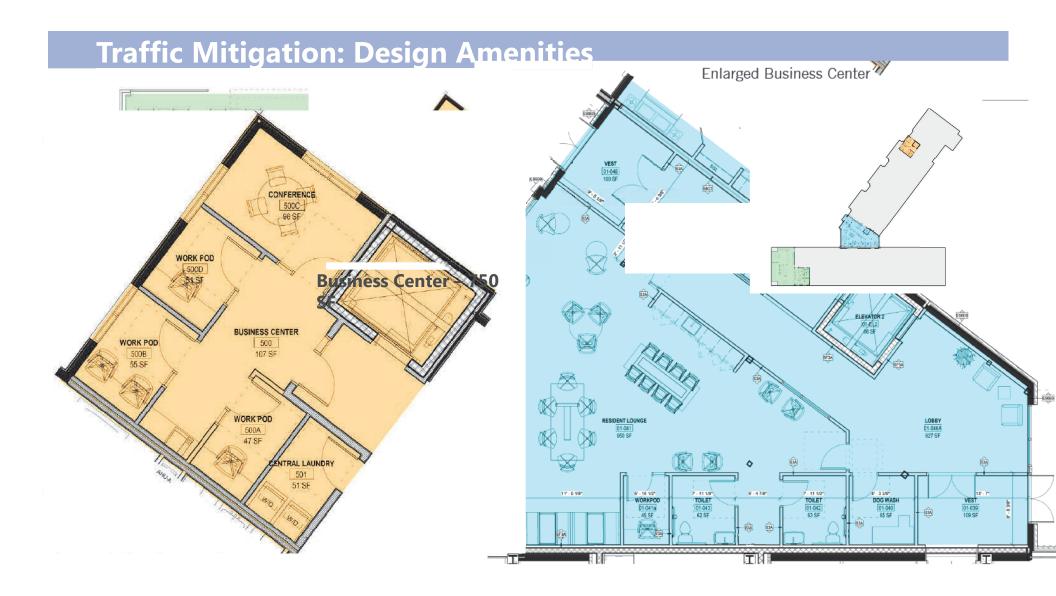

Traffic Mitigation: Design Amenities








Traffic Mitigation: Bicycle Opportunities

Concept Exploration

Bicycle Opportunities

- Met with Marketing Manager for Bluebikes to explore bike sharing – do not offer developer sponsored stations
- Implementation of minimum 4 bike racks accommodating at least 48 bikes at any point in time

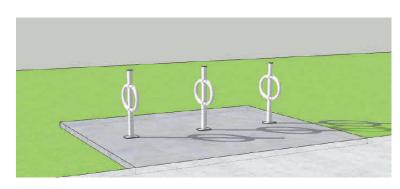



Potential Traffic Mitigation: Transit Screen

Concept Exploration

Transit Screen for Commuter Rail and Bus Services

- Met with head of sales to determine goals / needs of our project
- Received formal proposal
- Exploring success and utilization across similar properties





Potential Traffic Mitigation

Concept Exploration • Exploring ride sharing services like zipcar, Car2go • Reaching out to nearby residential projects about shuttle services implementation • EV Charging stations in garage

