
KING'S BEACH

SEAWALL REPAIRS SWAMPSCOTT, MA

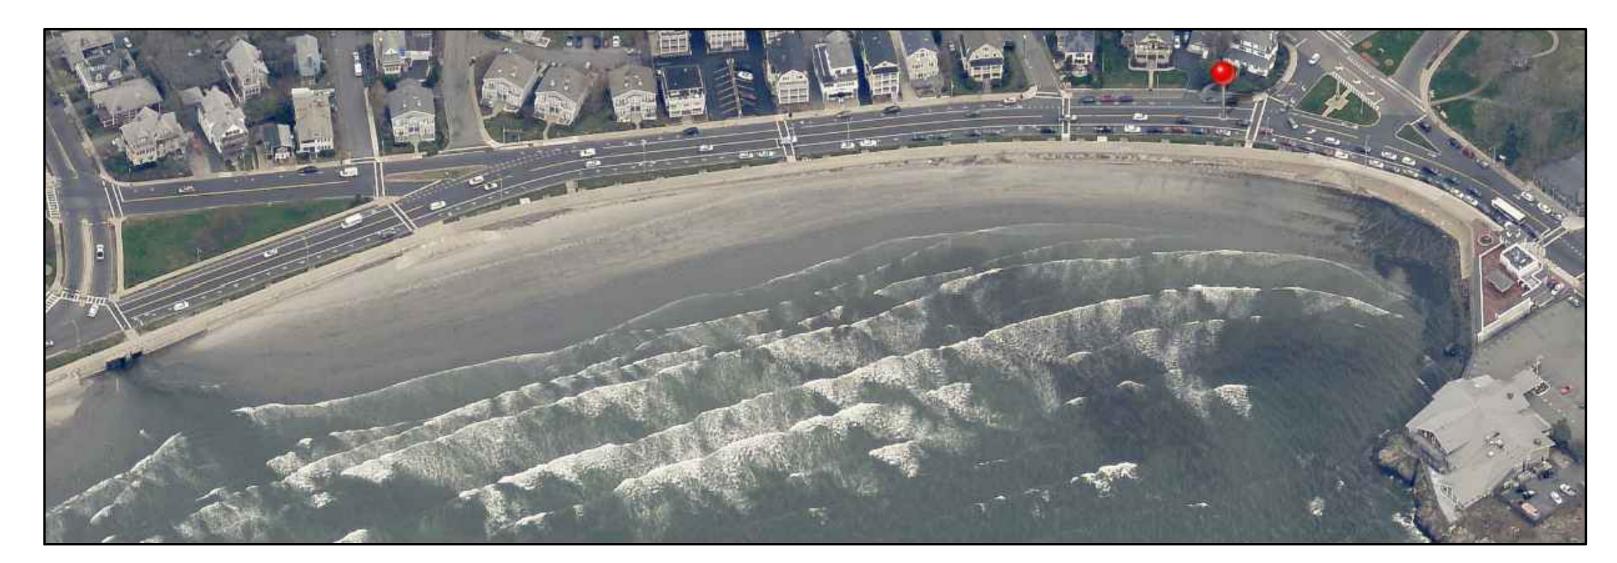

GENERAL NOTES

GENERAL REQUIREMENTS

- A. Prior to bidding, all bidders must view the premises and note conditions at and around where work is to be performed. Bidders shall fully inform themselves of all conditions affecting the work of this project.
- B. Refer to the Project Specifications for the General Conditions of the Contract for Construction, for the general requirements, and for the detailed requirements for materials and workmanship.
- C. The dimensions of the seawall and typical sections are approximate. The contractor shall field verify all existing conditions, including the configuration of all structural elements affecting the work.
- D. The Drawings show the approximate location of concrete deterioration. The contractor is responsible for visually inspecting and sounding all accessible concrete surfaces as required to discover and repair all concrete deterioration in accordance with the drawings and project specifications.
- E. Discrepancies and conflicts between the repairs and new elements, and the existing structure shall be brought to the attention of the engineer prior to the fabrication and construction of dependent work.
- F. Phased Construction
- 1. The Work shall be conducted in phases to maintain public beach egress and access throughout construction. The Contractor shall provide proposed phasing plans and an overall project schedule for Owner review and approval.

SCOPE OF WORK

- A. The work contemplated by the Contract Documents includes the work of all trades required and all labor, equipment, materials, access, and supervision necessary and incidental to the work indicated. The following descriptions of the work represent a brief summary of the project. For additional and more complete information, refer to the Drawings and Specifications.
- 1. Project Mobilization
 - a. This work shall include General Contractor and subcontractor mobilization costs. Include permits, temporary offices, bonding costs, etc.
- 2. Project General Requirements
 - a. This work shall include all miscellaneous work associated with the completion of the work in accordance with the Construction Documents. This shall include but not be limited to incidental shoring, barricades, debris containment, cleanup, dust and fume control, layout, equipment, waste disposal, documentation, obstruction removal and replacement, monthly as—built documents, and temporary heat, water, and utilities.
 - b. The Contractor shall coordinate construction phasing with the Owner.

B. Concrete Repair:

- a. Remove deteriorated and sound concrete to a minimum depth of 2 in. from the original wall surfaces.
- b. Prepare the concrete surface to receive a shotcrete overlay.
- c. Install shotcrete overlay (depth varies). Place GFRP bars and hooks where required.

C. Joint Sealants:

1. Install new joint sealant and backer rod at existing control joints in concrete curb at locations shown on the Drawings.

DRAWING LIST

C-0	COVER SHEET
E-0	EXISTING CONDITIONS
S-1	TYPICAL REPAIR DETAILS
S-2	SEAWALL REPAIR ELEVATIONS SECTIONS 1 & 2
S-3	SEAWALL REPAIR ELEVATIONS SECTIONS 3 & 4
S-4	SEAWALL REPAIR ELEVATIONS SECTIONS 5 & 6
S-5	SEAWALL REPAIR ELEVATIONS SECTIONS 7 & 8
S-6	SEAWALL REPAIR ELEVATIONS SECTIONS 9 & 10
S-7	SEAWALL REPAIR ELEVATIONS SECTIONS 11 & 12
S-8	SEAWALL REPAIR ELEVATIONS SECTIONS 13 & 14
S-9	SEAWALL REPAIR ELEVATIONS SECTIONS 15



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Chicago Houston Los Angeles New York San Francisco Washington, DC

Consultant

SEAWALL REPAIRS KING'S BEACH SWAMPSCOTT, MA

Description

Projec

Date

COVER SHEET

Drawing Title

Project No. Checked Date 200603.00 JGT 07/10/2020

Drawn Approved Scale AS NOTED

Drawing No.


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N.T.S.

1/2" = 1'-0"



WALL SECTIONS 1-12

APPROXIMATE WALL SECTION -WALL SECTIONS 13-15

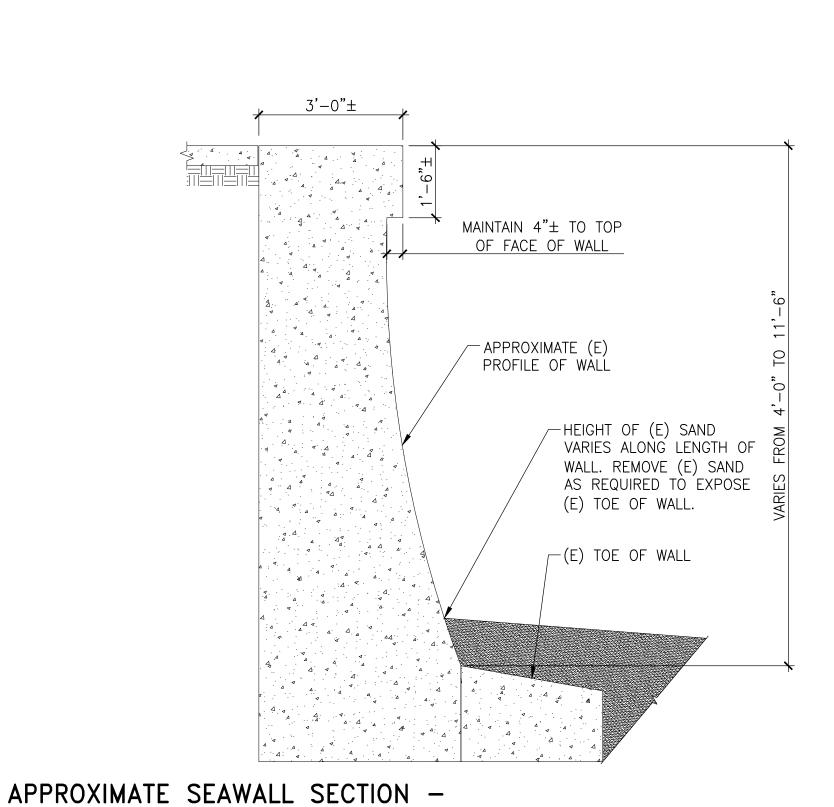PROFILE OF WALL

No. Date

Project No. 200603.00 Checked JGT Date 07/10/2020 Approved GGC Scale AS NOTED Drawing No.

Description

SEAWALL REPAIRS

KING'S BEACH

SWAMPSCOTT, MA

KEYPLAN AND

TYPICAL SEAWALL

SECTIONS

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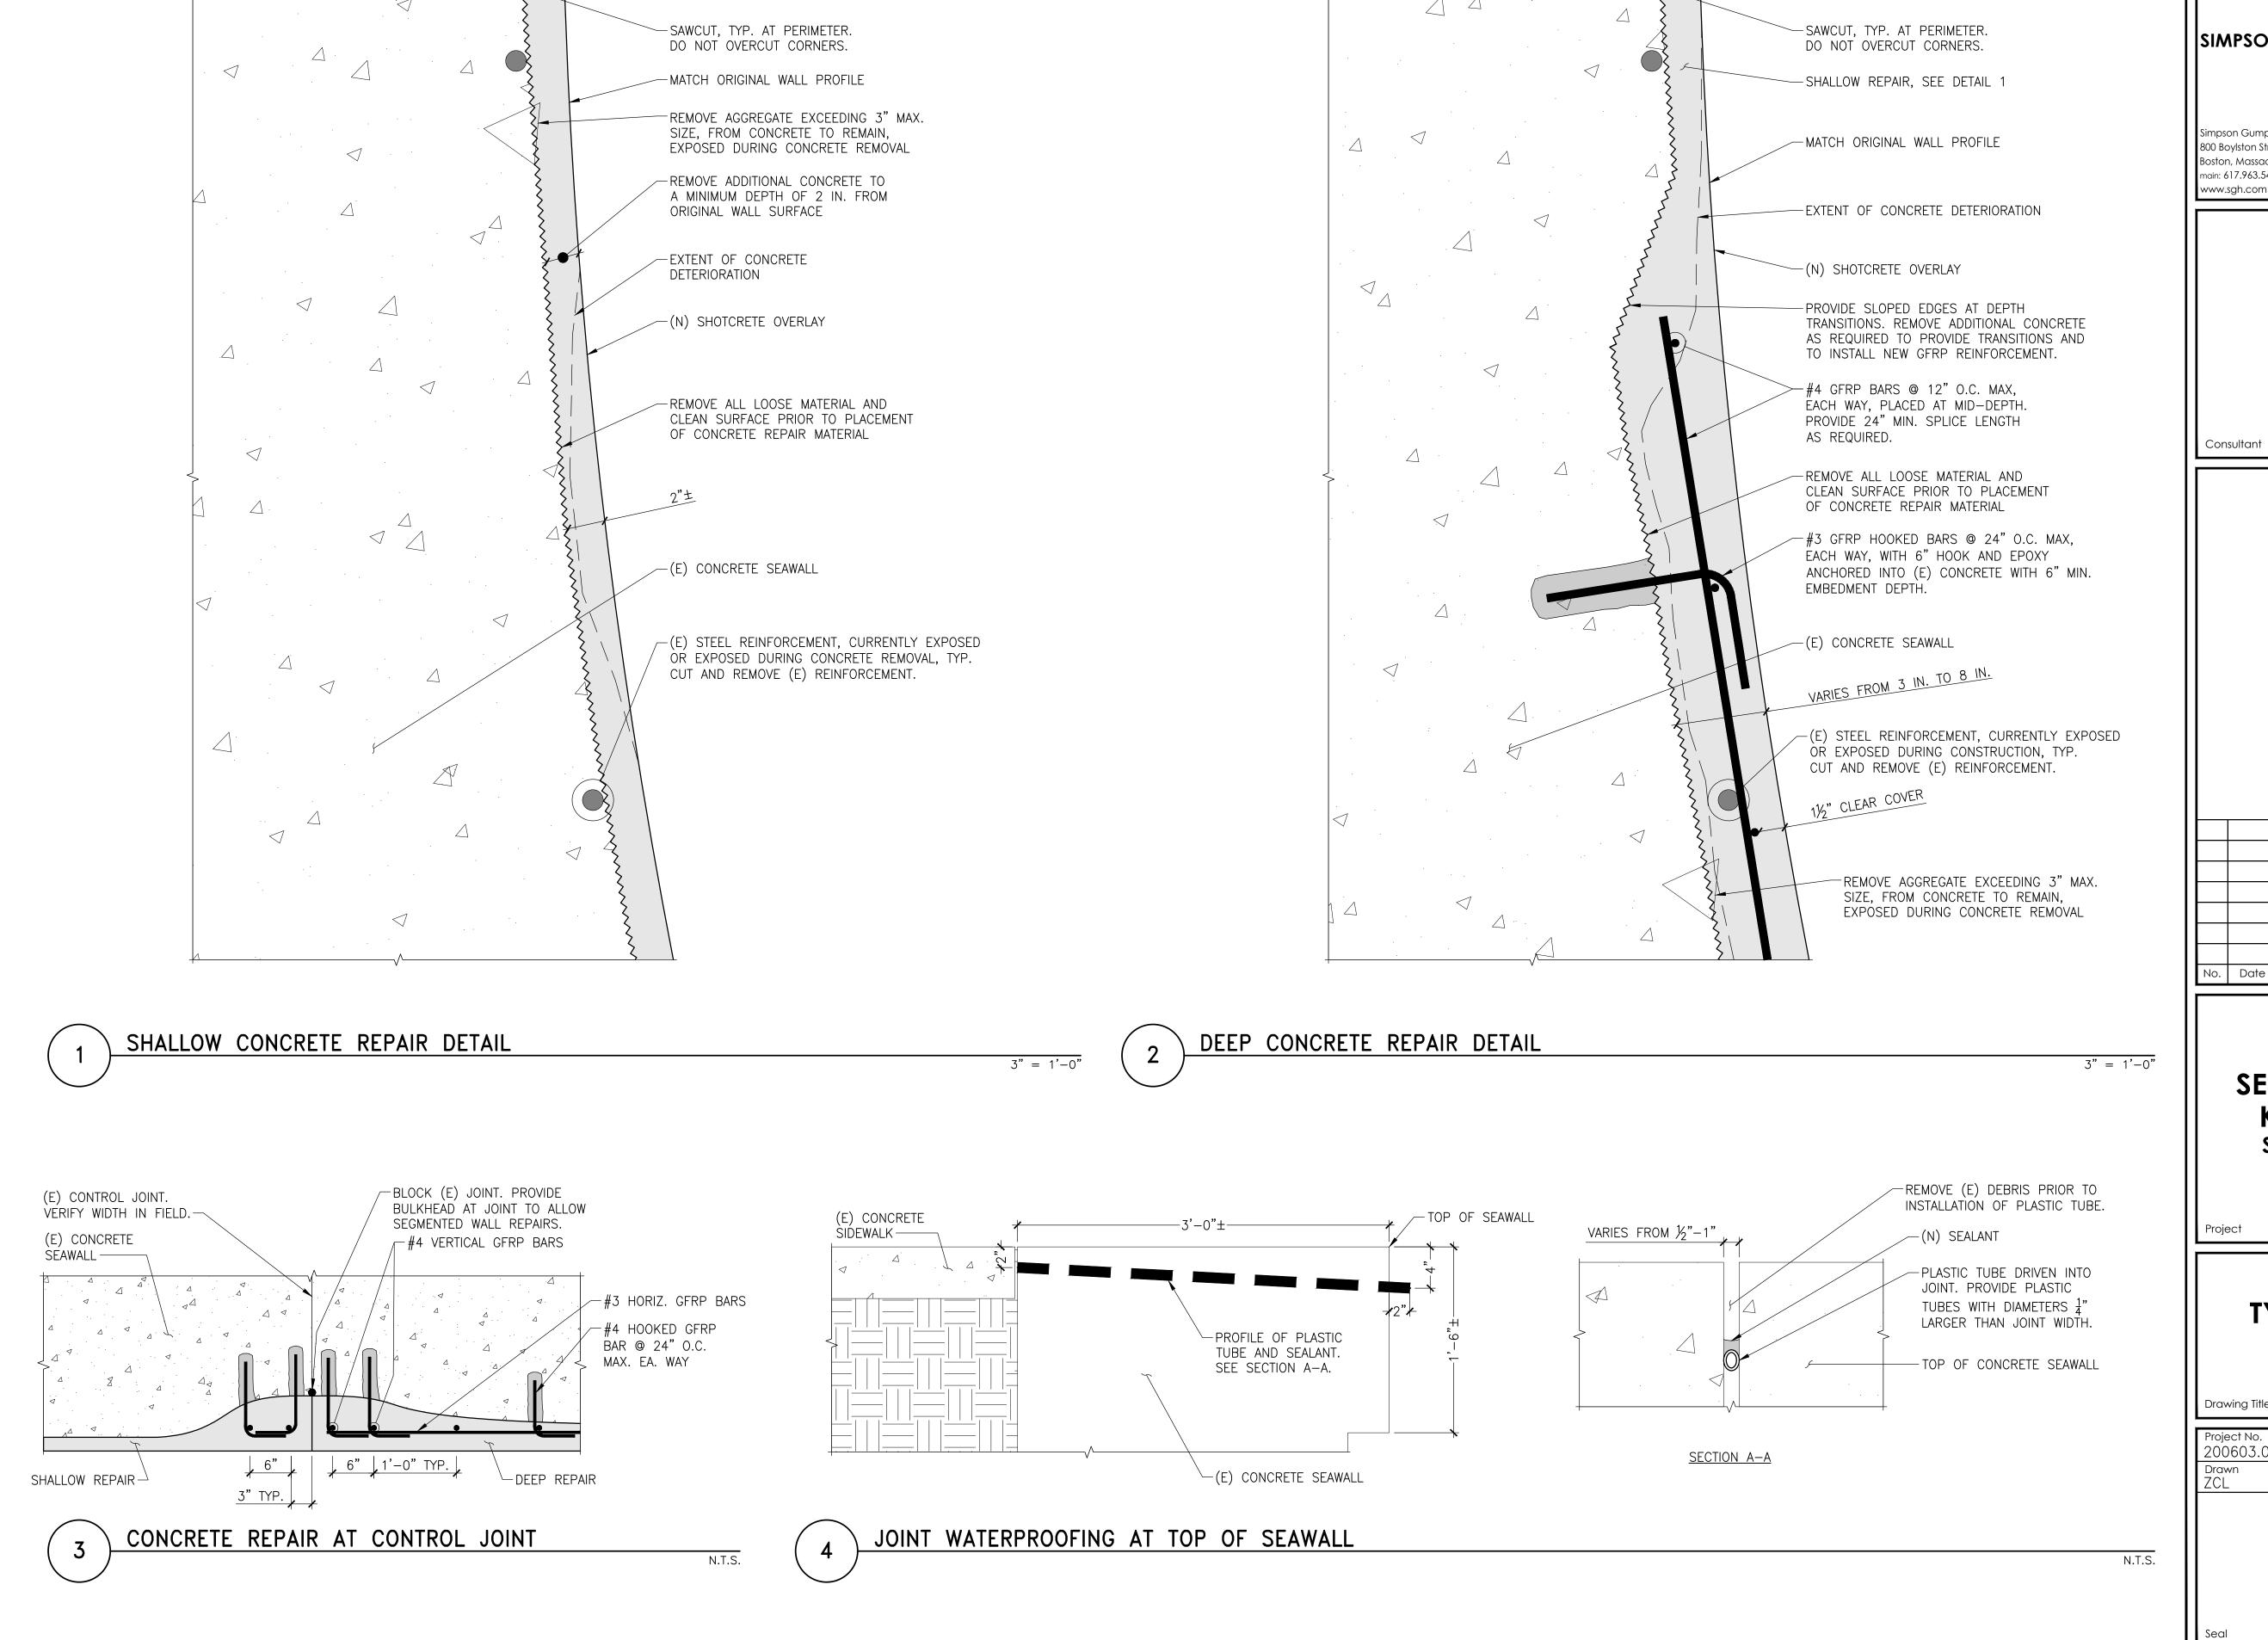
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1/2" = 1'-0"



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Date Description Ву

SEAWALL REPAIRS KING'S BEACH SWAMPSCOTT, MA

TYPICAL REPAIR **DETAILS**

200603.00	JGT	07/10/2020
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Drawing No.



INDICATES APPROXIMATE LOCATION AND EXTENTS OF SHALLOW CONCRETE REPAIR (SEE DETAIL 1/S-1).

QUANTITY: 560 SF

QUANTITY: 20 SF

INDICATES APPROXIMATE LOCATION AND EXTENTS OF DEEP CONCRETE REPAIR EXTENDING UP TO 4 IN. FROM ORIGINAL FACE OF WALL (SEE DETAIL 2/S-1).

QUANTITY: 20 SF

INDICATES APPROXIMATE LOCATION AND EXTENTS OF DEEP CONCRETE REPAIR EXTENDING GREATER THAN 4 IN. FROM ORIGINAL FACE OF WALL (SEE DETAIL 2/S-1).

SEAWALL REPAIR ELEVATION - SECTION 1

N.T.S.

(E) CONTROL JOINT, SEE DETAIL 4/S-1

LEGEND:

INDICATES APPROXIMATE LOCATION AND EXTENTS OF SHALLOW CONCRETE REPAIR (SEE DETAIL 1/S-1).

QUANTITY: 500 SF

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SEAWALL REPAIRS KING'S BEACH SWAMPSCOTT, MA

SEAWALL REPAIR ELEVATIONS SECTIONS 1 & 2

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SEAWALL REPAIR ELEVATION - SECTION 2



INDICATES APPROXIMATE LOCATION AND EXTENTS OF SHALLOW CONCRETE REPAIR (SEE DETAIL 1/S-1).

QUANTITY: 190 SF

INDICATES APPROXIMATE LOCATION AND EXTENTS OF DEEP CONCRETE REPAIR EXTENDING UP TO 4 IN. FROM ORIGINAL FACE OF WALL (SEE DETAIL 2/S-1).

QUANTITY: 10 SF



SEAWALL REPAIR ELEVATION - SECTION 3

APPROXIMATE FATENTS, OF SECTION 4

(S) CON ROL JOHN
SEE DETIAL 4/S-1

LEGEND:

INDICATES APPROXIMATE LOCATION AND EXTENTS OF SHALLOW CONCRETE REPAIR (SEE DETAIL 1/S-1).

QUANTITY: 355 SF

INDICATES APPROXIMATE LOCATION AND EXTENTS OF DEEP CONCRETE REPAIR EXTENDING GREATER THAN 4 IN. FROM ORIGINAL FACE OF WALL (SEE DETAIL 2/S-1).

QUANTITY: 15 SF



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KING'S BEACH
SWAMPSCOTT, MA

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SEAWALL REPAIR
ELEVATIONS
SECTIONS 3 & 4

Drawing Tit

Project No. 200603.00	Checked JGT	Date 07/10/2020
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ZCL	GGC	AS NOTED

Drawing No.

S-3

SEAWALL REPAIR ELEVATION - SECTION 4

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SEAWALL REPAIR ELEVATION - SECTION 5

CONTROLLER S. D. STILLS S. D. S

LEGEND:

INDICATES APPROXIMATE LOCATION AND EXTENTS OF SHALLOW CONCRETE REPAIR (SEE DETAIL 1/S-1).

INDICATES APPROXIMATE LOCATION AND EXTENTS OF SHALLOW CONCRETE REPAIR (SEE DETAIL 1/S-1).

QUANTITY: 600 SF

QUANTITY: 550 SF



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Description By

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KING'S BEACH
SWAMPSCOTT, MA

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SEAWALL REPAIR
ELEVATIONS
SECTIONS 5 & 6

Drawing Ti

Project No. Checked Date 200603.00 JGT 07/10/2020

Drawn Approved Scale AS NOTED

Drawing No.

S-4



INDICATES APPROXIMATE LOCATION AND EXTENTS OF SHALLOW CONCRETE REPAIR (SEE DETAIL 1/S-1).

QUANTITY: 800 SF

INDICATES APPROXIMATE LOCATION AND EXTENTS OF DEEP CONCRETE REPAIR EXTENDING UP TO 4 IN. FROM ORIGINAL FACE OF WALL (SEE DETAIL 2/S-1).

QUANTITY: 30 SF



SEAWALL REPAIR ELEVATION - SECTION 7



LEGEND:

INDICATES APPROXIMATE LOCATION AND EXTENTS OF SHALLOW CONCRETE REPAIR (SEE DETAIL 1/S-1).

QUANTITY: 700 SF

QUANTITY: 75 SF

INDICATES APPROXIMATE LOCATION AND EXTENTS OF DEEP CONCRETE REPAIR EXTENDING UP TO 4 IN. FROM ORIGINAL FACE OF WALL (SEE DETAIL 2/S-1).

INDICATES APPROXIMATE LOCATION AND EXTENTS OF DEEP CONCRETE REPAIR EXTENDING GREATER THAN 4 IN. FROM ORIGINAL FACE OF WALL (SEE DETAIL 2/S-1).

QUANTITY: 75 SF

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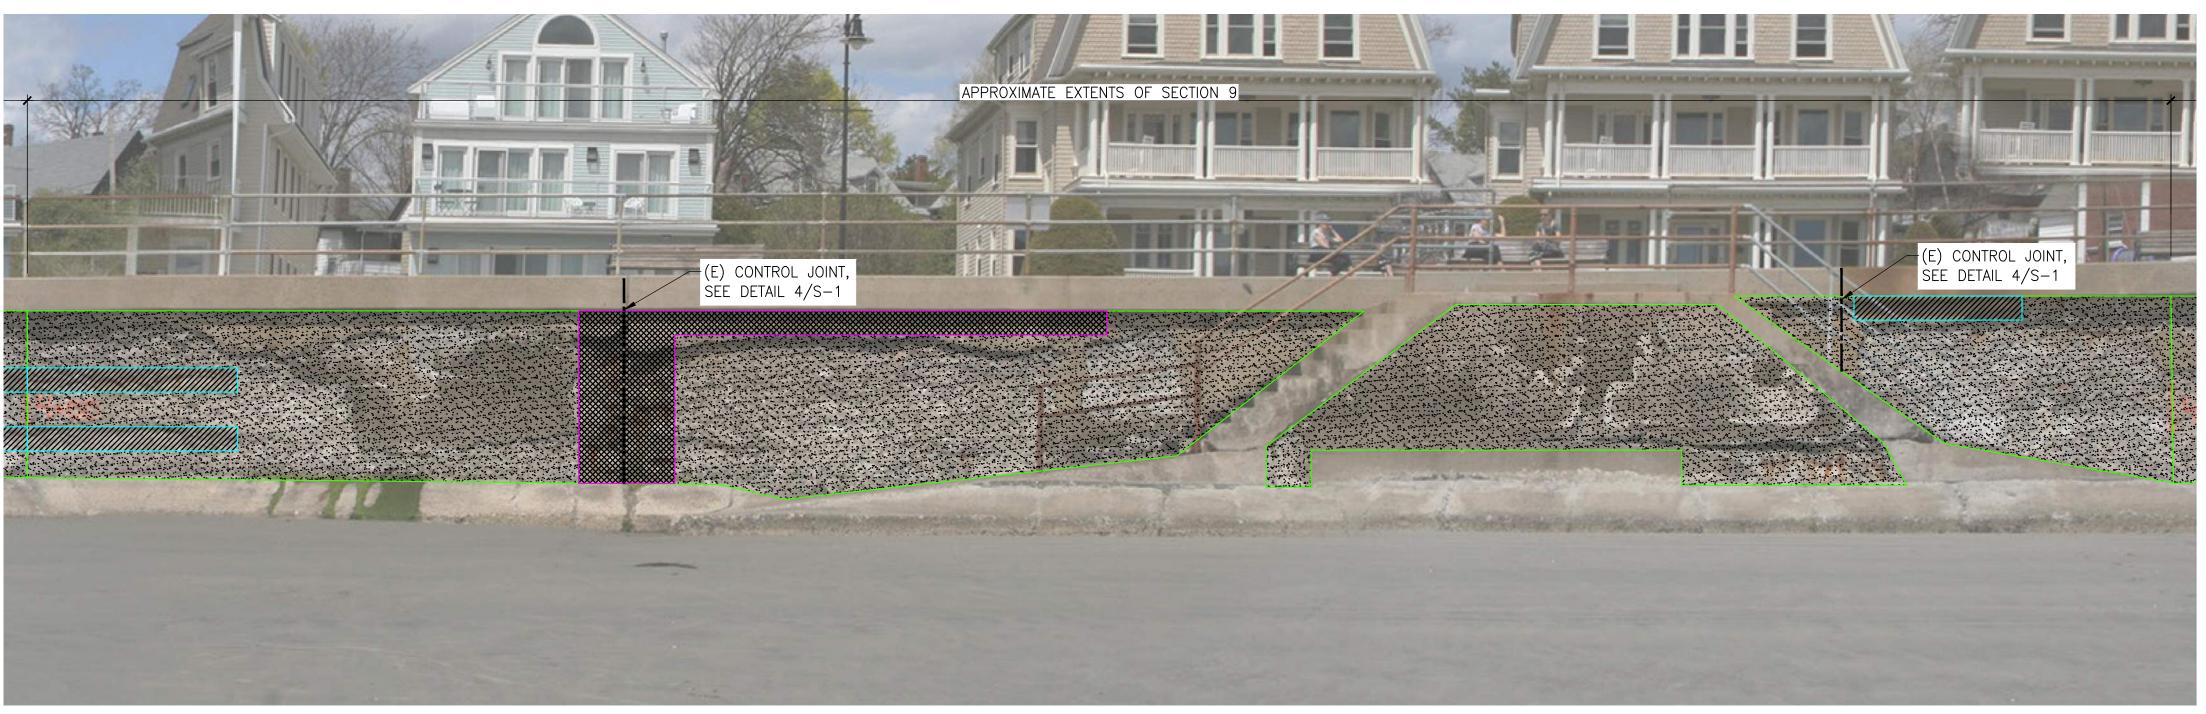
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SEAWALL REPAIRS KING'S BEACH SWAMPSCOTT, MA

SEAWALL REPAIR **ELEVATIONS** SECTIONS 7 & 8

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ZCL	GGC	AS NOTED

SEAWALL REPAIR ELEVATION - SECTION 8



INDICATES APPROXIMATE LOCATION AND EXTENTS OF SHALLOW CONCRETE REPAIR (SEE DETAIL 1/S-1).

QUANTITY: 775 SF

QUANTITY: 50 SF

INDICATES APPROXIMATE LOCATION AND EXTENTS OF DEEP CONCRETE REPAIR EXTENDING UP TO 4 IN. FROM ORIGINAL FACE OF WALL (SEE DETAIL 2/S-1).

QUANTITY: 75 SF

INDICATES APPROXIMATE LOCATION AND EXTENTS OF DEEP CONCRETE REPAIR EXTENDING GREATER THAN 4 IN. FROM ORIGINAL FACE OF WALL (SEE DETAIL 2/S-1).



SEAWALL REPAIR ELEVATION - SECTION 9

APPROXIMATE EXTENTS OF SECTION 10 (E) CONTROL JOINT, SEE DETAIL 4/S-1 SEE DETAIL 4/S-1

LEGEND:

INDICATES APPROXIMATE LOCATION AND EXTENTS OF SHALLOW CONCRETE REPAIR (SEE DETAIL 1/S-1).

QUANTITY: 950 SF



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SEAWALL REPAIR **ELEVATIONS** SECTIONS 9 & 10

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SEAWALL REPAIR ELEVATION - SECTION 10

N.T.S.



INDICATES APPROXIMATE LOCATION AND EXTENTS OF SHALLOW CONCRETE REPAIR (SEE DETAIL 1/S-1).

QUANTITY: 1050 SF



SEAWALL REPAIR ELEVATION - SECTION 11



LEGEND:

INDICATES APPROXIMATE LOCATION AND EXTENTS OF SHALLOW CONCRETE REPAIR (SEE DETAIL 1/S-1).

QUANTITY: 1150 SF



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SEAWALL REPAIRS
KING'S BEACH
SWAMPSCOTT, MA

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SEAWALL REPAIR
ELEVATIONS
SECTIONS 11 & 12

Drawing


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ZCL	GGC	AS NOTED

Drawing No.

S-7

SEAWALL REPAIR ELEVATION - SECTION 12

S.

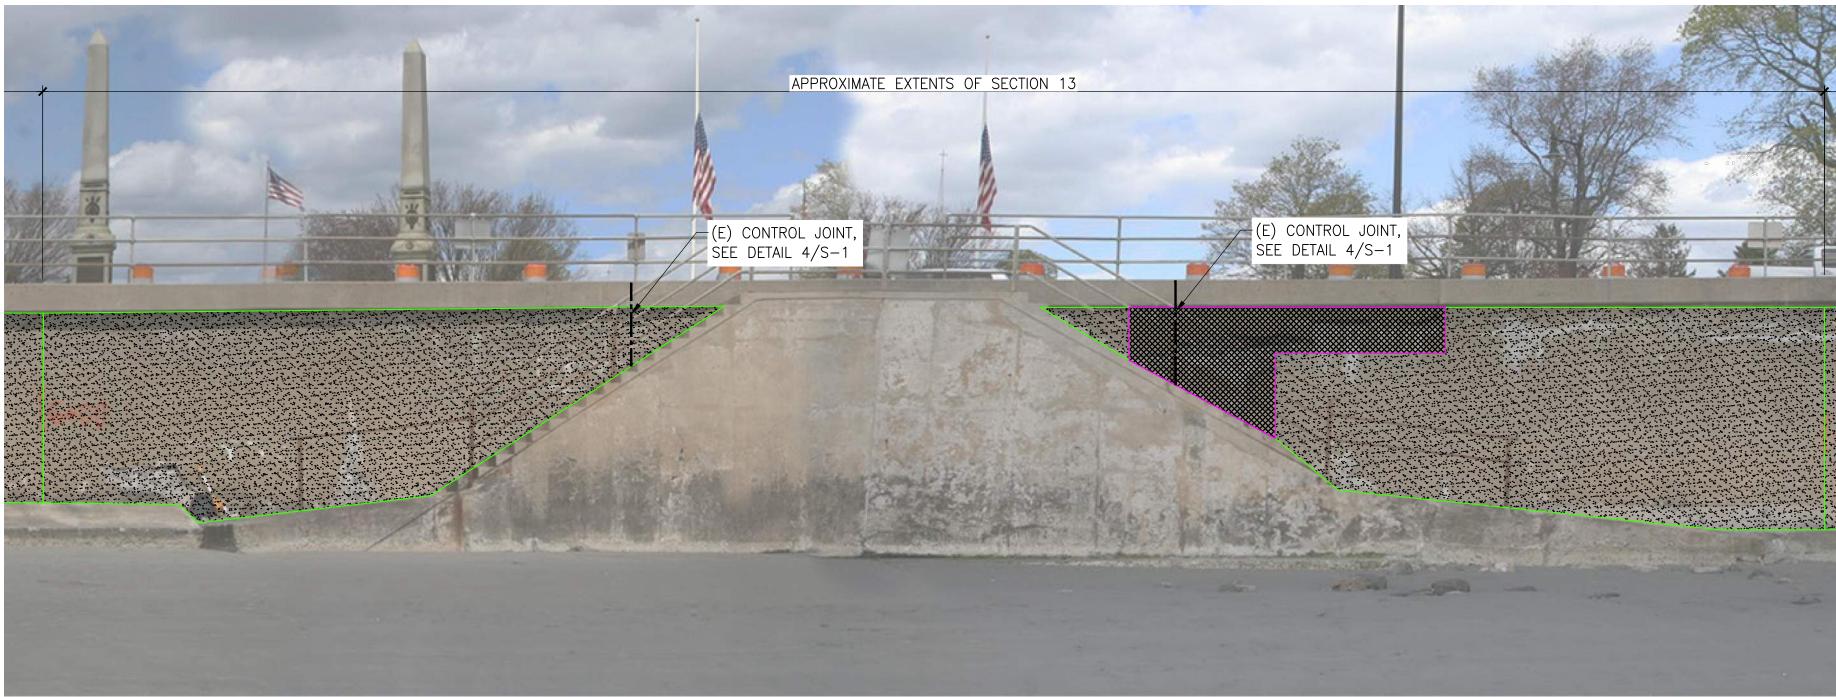

INDICATES APPROXIMATE LOCATION AND EXTENTS OF SHALLOW CONCRETE REPAIR (SEE DETAIL 1/S-1).

QUANTITY: 900 SF

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INDICATES APPROXIMATE LOCATION AND EXTENTS OF DEEP CONCRETE REPAIR EXTENDING GREATER THAN 4 IN. FROM ORIGINAL FACE OF WALL (SEE DETAIL 2/S-1).

QUANTITY: 100 SF



SEAWALL REPAIR ELEVATION - SECTION 13

APPROXIATE EXTENTS OF SECTION 14

(E) CONTROL JOINT,
SEE DETAIL 4/S 1

LEGEND:

INDICATES APPROXIMATE LOCATION AND EXTENTS OF SHALLOW CONCRETE REPAIR (SEE DETAIL 1/S-1).

QUANTITY: 1500 SF



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SEAWALL REPAIR ELEVATIONS SECTION 13 & 14

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ZCL GGC AS NOTED

Drawing No.

S-8

SEAWALL REPAIR ELEVATION - SECTION 14

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INDICATES APPROXIMATE LOCATION AND EXTENTS OF SHALLOW CONCRETE REPAIR (SEE DETAIL 1/S-1).

QUANTITY: 1250 SF



SEAWALL REPAIR ELEVATION - SECTION 15

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WALL REPAIR ELEVATIONS

Drawing Titl

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S-9

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